KONERU SHORT PLAT, SUB21-008

6610 EAST MERCER WAY MERCER ISLAND, WA. 98040

PROJECT CONTACTS

OWNER/APPLICANT: DHEERAJ KONERU

7002 93RD AVENUE SE MERCER ISLAND, WA 98040

ENGINEER/SURVEY: PACE ENGINEERS, INC.

11255 KIRKLAND WAY, SUITE 300 KIRKLAND, WA 98033 JOHN ANDERSON, PE BILL HAWKINS, PLS PHONE: (425) 827-2014

JOHNA@PACEENGRS.COM BILLH@PACEENGRS.COM

ARBORIST: TREE 133, LLC

12408 17TH AVENUE NE SEATTLE, WA. 98125 CRAIG BACHMANN, CERTIFIED ARBORIST PHONE: (206) 745-0473

GEOTECHNICAL: GEOTECH CONSULTANTS. INC.

2401 10TH AVENUE E. SEATTLE, WA 98102 MARC MCGINNIS, PE PHONE: (425) 747-5618

PROJECT INFORMATION

SITE DATA

6610 EAST MERCER WAY ADDRESS: 3024059153 PARCEL NUMBER: 50,094 SF

PARCEL AREA: LEGAL DESCRIPTION:

THE SOUTH HALF OF THAT PORTION OF GOVERNMENT LOT 1, SECTION 30, TOWNSHIP 24 NORTH, RANGE 5 EAST, LYING BETWEEN THE NORTH 498 FEET THEREOF AND SOUTH 471 FEET THEREOF AND EASTERLY OF A LINE PARALLEL WITH AND 1588.78 FEET EASTERLY OF (MEASURED AT RIGHT ANGLES TO) THE WEST LINE OF THE NORTHEAST QUARTER OF SAID SÉCTION 30; EXCEPT THE SOUTH 9 FEET THEREOF.

> TOGETHER WITH SHORELANDS OF THE SECOND CLASS IN FRONT AND ABUTTING UPON SAID PORTION OF SADI GOVERNMENT LOT 1.

TOGETHER WITH AN EASEMENT FOR UNOBSTRUCTED INGRESS AND EGRESS OVER THE EXISTING PRIVATE ROADWAY EXTENDING NORTHWESTERLY TO EAST MERCER WAY APPURTENANT TO THE PROPERTY HEREBY CONVEYED.

SITUATE IN THE CITY OF MERCER ISLAND, COUNTY OF KING, STATE OF WASHINGTON

ZONING SUMMARY

EXISTING ZONING: R - 15

MINIMUM LOT SIZE: 15,000 SQ. FT.

MAXIMUM HEIGHT: 30' ABOVE ABE

MAX. LOT COVERAGE: LOT 1 13,591 SQ. FT. (40% OF LOT AREA) LOT 2 6,826 SQ. FT.


MAX. HARDSCAPE: LOT 1 3,058 SQ. FT (9% OF LOT AREA) LOT 2 1,536 SQ. FT.


MAX GROSS FLOOR AREA: LOT 1 12,000 SQ. FT. (MAX ALLOWED) LOT 2 6,826 SQ. FT. (40% OF LOT AREA)

BUILDING SETBACKS

SUM 15' WITH 5' MIN.

REAR: 25 FRONT: 20

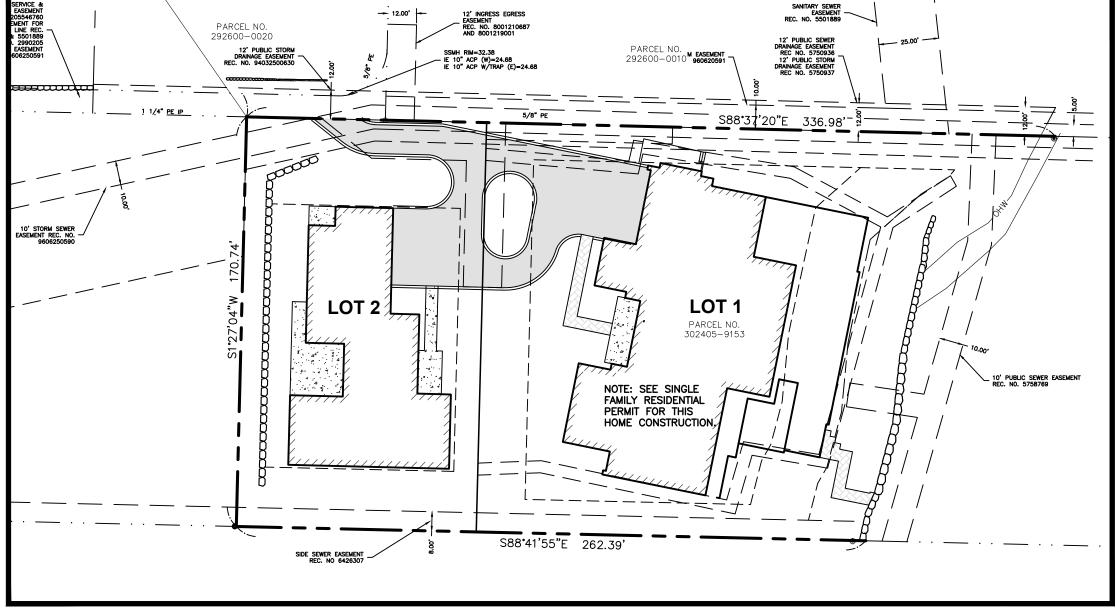


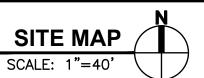

PROJECT INFORMATION

DEVELOPMENT SUMMA	RY	
PROPOSED NUMBER LOTS:	2	
NUMBER OF DWELLING UNITS:	2	
GROSS SITE AREA:	50,094	SQ. FT.
NET SITE AREA:	50,094	SQ. FT.
LOT SIZE:	LOT 1 33,978	SQ. FT. *
	LOT 2 17,067	SQ. FT.
GROSS DENSITY:	1.73	DU/AC
NET DENSITY:	1.73	DU/AC
EXISTING IMPERVIOUS AREA:	9,862	SQ. FT.
PROPOSED IMPERVIOUS AREA:	LOT 1 12,000	SQ. FT.
	LOT 2 7,785	SQ. FT.
LOT WIDTH:	LOT 1 100	FT.
	LOT 2 162	FT. (MIN)
LOT DEPTH: LOT 1	= LOT 2 = 171	FT.
PARKING SPACES:	COVERED	UNCOVERED
LOT 1	3	3
LOT 2	3	3
LOT SLOPE:	6.6%	

* LIMIT SUBDIVISION WITH NOTE ON TITLE

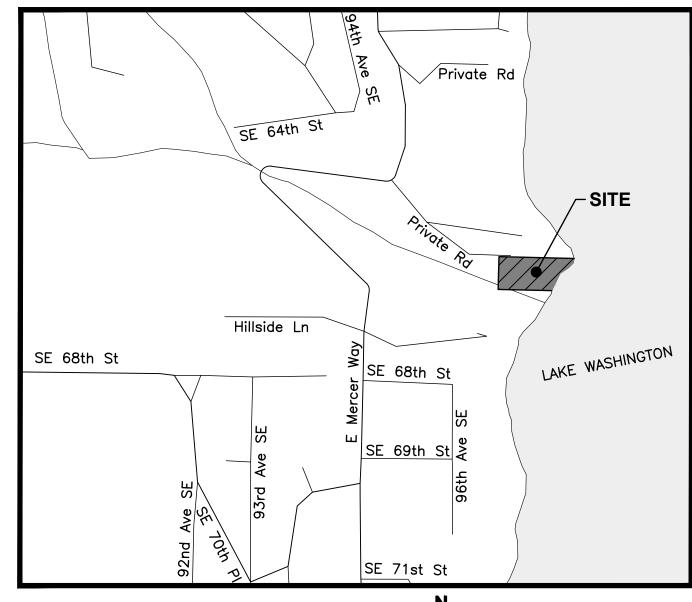

VICINITY MAP	
1"=500'	

	SHEET INDEX				
SHEET NO.		SHEET TITLE			
	C0.0	COVER SHEET			
	C0.1	EXISTING CONDITIONS			
	C1.0	PRELIMINARY SHORT PLAT			
	C2.0	GRADING & DRAINAGE PLAN			
	C3.0	COMPOSITE UTILITY PLAN			
	L1.0	TREE RETENTION PLAN			

CITY OF MERCER ISLAND FILE NUMBER

PRE-SUBMITTAL CONFERENCE NUMBER: PRE21-023

UTILITY PURVEYORS

CITY OF MERCER ISLAND WATER: SEWER: CITY OF MERCER ISLAND **ELECTRICITY:** PUGET SOUND ENERGY PUGET SOUND ENERGY TELEPHONE: CENTURY LINK CENTURY LINK/XFINITY CABLE: MERCER ISLAND SCHOOL DISTRICT SCHOOL DISTRICT:

EARTHWORK SUMMARY


APPROX. CUT 464 CY APPROX. FILL 1251 CY NET 787 CY FILL

THIS REQUEST DOES NOT GUARANTEE THAT THE LOTS WILL BE SUITABLE FOR DEVELOPEMENT NOW OR IN THE FUTURE. THE LEGAL TRANSFER OF THE PROPERTY MUST BE DONE BY SEPARATE INSTRUMENT UNLESS ALL LOTS HEREIN ARE UNDER THE SAME OWNERSHIP. ALL BUILDINGS ARE SUBJECT TO MEETING THE CURRENT FIRE CODE REQUIREMENTS AT THE TIME OF THE PERMIT SUBMITTAL. ACCESS SHALL BE PROVIDED AS OUTLINED IN THE INTERNATIONAL FIRE CODE APPENDIX D AS ADOPTED AND/OR AMENDED AND MICC 19.09.40. FIRE PLAN REVIEWS WILL BE CONDUCTED AT THE TIME OF BUILDING PERMIT SUBMITTAL AND MAY REQUIRE ADDITIONAL FIRE PROTECTION SYSTEMS AND/OR FIRE PREVENTION MEASURES FOR PERMIT APPROVAL.

> **CALL BEFORE** YOU DIG 811

					4/	
					RESPONSE TO CITY COMMENTS	NOINI
					1	Ž
		An Engineering Services Company	11255 Kirkland Way, Suite 300 Kirkland WA 98033	p. 425.827.2014 f. 425.827.5043	 CIVII Suluctulal Platifilling Sulvey www.paceengrs.com	



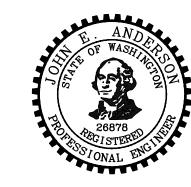

KONERU T PLAT (21 EAST MERCER V

VERIFY SCALE BAR IS ONE INCH ON ORIGINAL DRAWIN ADJUST SCALES ACCORDINGLY.

07/20/21 AS SHOWN DESIGNED BY: CHECKED BY: PACE PROJECT NO. 21436.00

SHEET

